PROPOSED BRANCH BANK at 222 & 236 COCHITUATE ROAD in FRAMINGHAM, MA



ZONING INFORMATION

1. ZONING DISTRICT: OFFICE AND PROFESSIONAL HIGHWAY OVERLAY DISTRICT: REGIONAL CENTER

	REQUIRED:	EXISTING:	EXISTING PRIOR TO HIGHWAY TAKING:	PROPOSED:	PROPOSED PRIOR TO HIGHWAY TAKING:
LOT AREA	6,000 S.F. MIN.	24,527± S.F.	27,007± S.F.	24,527± S.F.	27,007± S.F.
LOT FRONTAGE	50 FT. MIN.	281± FT.	294± FT.	281± FT.	294± FT.
FRONT YARD SETBACK	30 FT. MIN.	12.7 FT.	22.8 FT.	35.8 FT.	45.8 FT.
SIDE YARD SETBACK	15 FT. MIN.	21.8 FT.	21.8 FT.	17.5 FT.	17.5 FT.
BUILDING HEIGHT	3 FL/40 FT. MAX.	2 FL/<40 FT.	2 FL/<40 FT.	2 FL/30 FT.	2 FL/30 FT.
LANDSCAPED OPEN SPACE	20% MIN.	73.8%	67.0%	29.3%	35.8%
FLOOR AREA RATIO	0.32 MAX.	0.7	0.6	0.22	0.19
MAXIMUM BUILDING COVERAGE	20% MAX.	<i>3.5%</i>	<i>3.1%</i>	10.8 <u>%</u>	9.8%
PARKING — FRONT PROPERTY LINE SETBACK	15 FT. MIN.	37 FT.	47 FT.	10 FT.	20 FT.
PARKING - SIDE PROPERTY LINE SETBACK	5 FT. MIN.	O FT.	0 FT.	5 FT.	5 FT.
PARKING — BÜILDING LINE SETBACK	10 FT. MIN.	0 FT.	0 FT.	10 FT.	10 FT.

2. LOT AREA PERCENTAGES:	PROPOSED:	PROPOSED PRIOR TO HIGHWAY TAKING:
LOT COVERAGE OF BUILDING PAVED SURFACE COVERAGE LANDSCAPED OPEN SPACE	10.8% ± 59.9% ± 29.3% ±	9.8% ± 54.4% ± 35.8% ±
	TOTAL: 100%	TOTAL: 100%
	en e	

3. SITE PLAN PROVISIONS:	EXISTING	PROPOSED	<i>INCREASE</i>
GROSS FLOOR AREA # OF PARKING SPACES	1,700 S.F.	5,313 S.F.	3,615 S.F.
	16 SPACES	27 SPACES	11 SPACES

4. <u>PARKING REQUIREMENTS:</u> BANK=1 SPACE PER 175 S.F. OF GROSS FLOOR AREA; PLUS 1 SPACE PER 250 S.F. OF GROSS FLOOR AREA FOR AREAS NOT DEVOTED TO CUSTOMER SERVICE.

GROSS FLOOR AREA=5,313 S.F.

-TOTAL AREA DEVOTED TO CUSTOMER SERVICE=3,464 S.F.
3,464 S.F. / 175 S.F. = 19.8 CARS

-TOTAL AREA DEVOTED TO NON-CUSTOMER SERVICE=1,733 S.F. 1,733 S.F. / 250 S.F. = 6.93 CARS


TOTAL=27 CARS REQUIRED
27 CARS PROVIDED

HANDICAPPED ACCESSIBLE PARKING:MINIMUM REQUIRED PER 521 CMR= 2PROPOSED= 2

DRAWING LIST

	4
CE-1	COVER SHEET
CE-2	EXISTING CONDITIONS PLAN
CE-3	LAYOUT & UTILITY PLAN
CE-4	GRADING & DRAINAGE PLAN
CE-5	EROSION & SEDIMENTATION
	CONTROL PLAN & DETAILS
CE-6	DETAIL SHEET #1
CE-7	DETAIL SHEET #2
CE-8	DETAIL SHEET #3

Chalifoux Realty, LLC 277 Linden Street, Suite 209 Wellesley, MA 02482 APPLICANT: Avidia Bank 42 Main Street Hudson, MA 01749 PROJECT TITLE: PROPOSED **BRANCH BANK** PLAN TITLE: COVER SHEET DATE: APRIL 4, 2014 SCALE: AS NOTED DRAWN BY: CHECKED BY: APPROVED BY: SCHOFIELD BROTHERS OF NEW ENGLAND, INC. ENGINEERING SURVEYING PLANNIN 1071 WORCESTER ROAD FRAMINGHAM, MA 01701 COPYRIGHT © 2014, BY SCHOFIELD BROTHERS OF NEW ENGLAND INC SHEET: CE-1

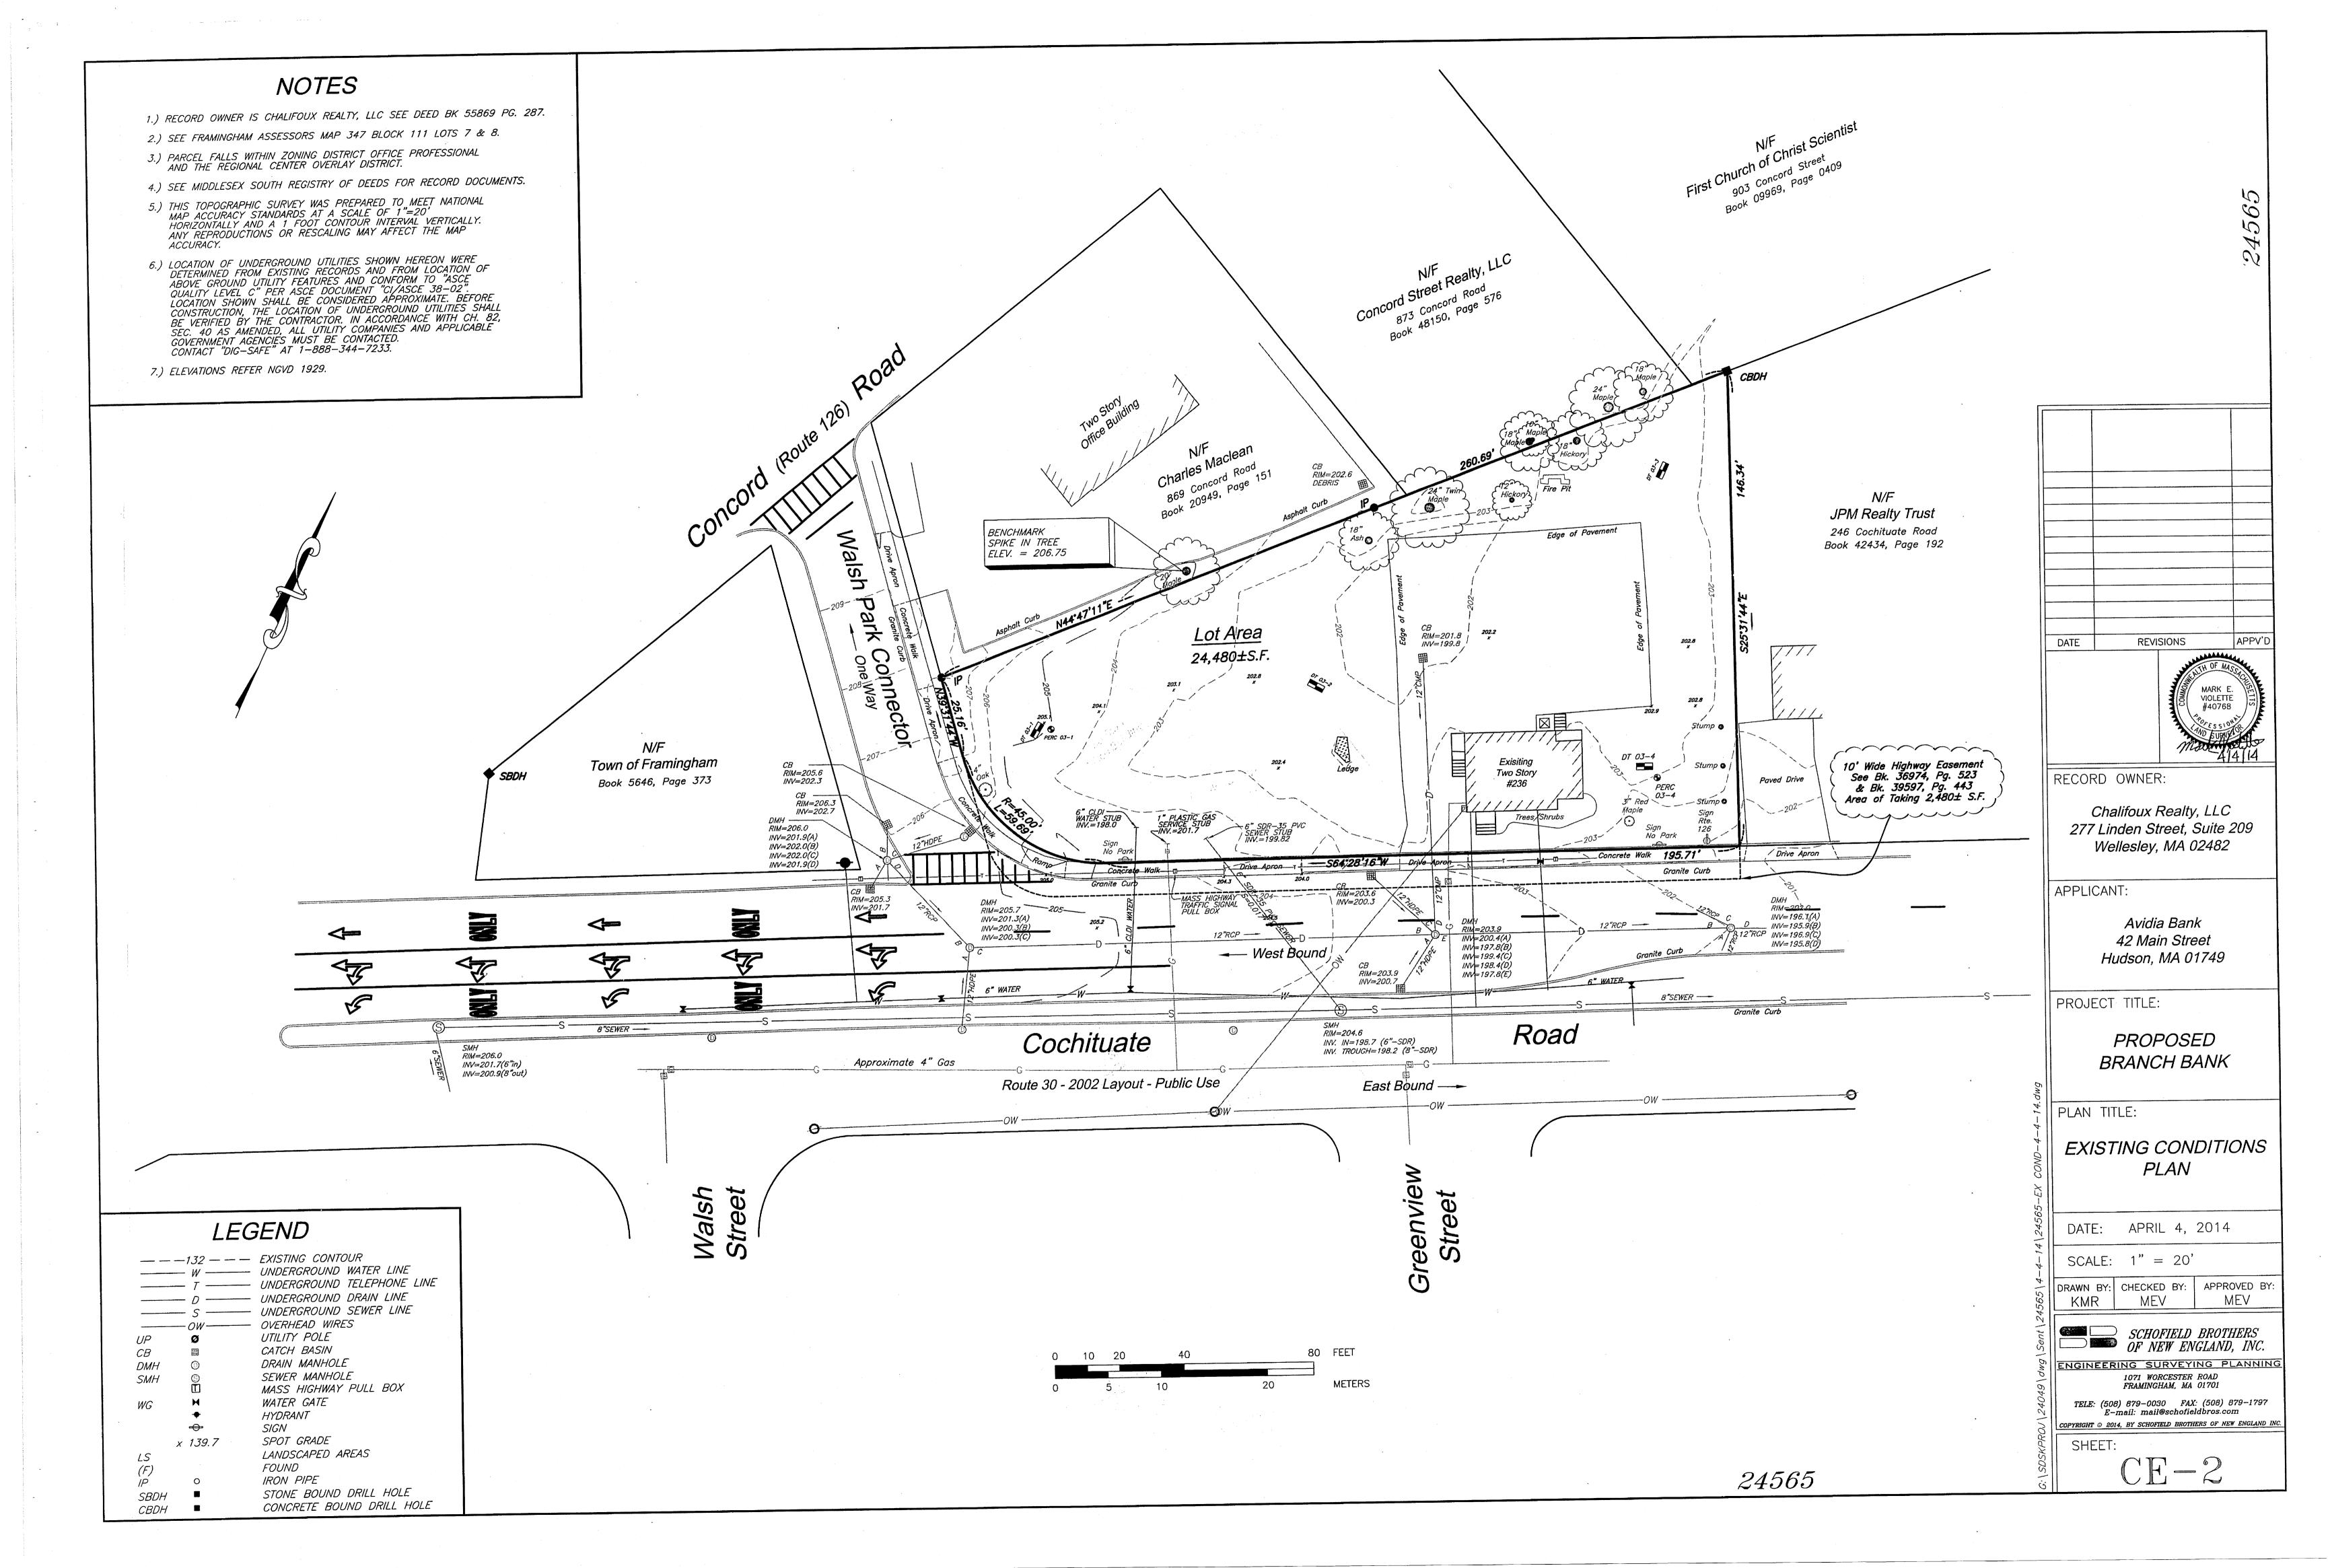

- 1.) ALL ACCESSIBLE CURB CUTS SHALL BE CONSTRUCTED TO MEET A.D.A. AND M.A.A.B. REQUIREMENTS. - AT AREAS OF VERTICAL GRANITE CURB, TRANSITIONAL VERTICAL
- GRANITE CURB AND FLUSH GRANITE CURB SHALL BE PROVIDED AS NECESSARY. SEE NOTE 4 BELOW.
- 2.) HANDICAP PARKING SPACES AND ACCESS AISLES SHALL NOT EXCEED A SLOPE OF 1:50 (2%) IN ANY DIRECTION.
- 3.) WALKWAY GRADES SHALL NOT HAVE SLOPES IN EXCESS OF 1:20 (5%) OR CROSS SLOPES IN EXCESS OF 1:50 (2%), UNLESS OTHERWISE NOTED.
- 4.) WALK GRADIENTS AND CROSS SLOPES SHOWN ON THE GRADING PLANS ARE WITHIN, OR LESS THAN, THE REQUIREMENTS OF THE MASSACHUSETTS ARCHITECTURAL ACCESS BOARD'S (MAAB) REGULATIONS. IT IS THE CONTRACTOR'S RESPONSIBILITY TO CONSTRUCT THE WORK SO THAT IT IS COMPLIANT WITH ALL REQUIRED REGULATIONS. NOTE THAT THE MAXIMUM GRADIENTS WITHIN THE REGULATIONS DO NOT RECOGNIZE "CONSTRUCTION TOLERANCES." EXCEEDING THE MAXIMUM GRADIENTS IN THE REGULATIONS IS ENTIRELY AT THE CONTRACTOR'S RISK. THE CONTRACTOR SHALL VERIFY IN WRITING THAT ALL WALKS HAVE BEEN CONSTRUCTED IN COMPLIANCE WITH THE MAAB'S REGULATIONS.
- 5.) CURB RADII AND DIMENSIONS SHOWN ARE AT THE FACE OF CURB.
- 6.) IN CASES WHERE LEDGE OR BOULDERS ARE PRESENT, SCHOFIELD BROTHERS OF NEW ENGLAND, INC. WILL NOT BE RESPONSIBLE FOR THE AMOUNT OF ROCK ENCOUNTERED.

- 7.) ALL INSTALLATION AND CONSTRUCTION TO BE IN ACCORDANCE WITH THE LATEST TOWN OF FRAMINGHAM DPW RULES AND REGULATIONS.
- 8.) SCHOFIELD BROTHERS OF NEW ENGLAND, INC. SHALL BE NOTIFIED OF ANY SIGNIFICANT DIFFERENCES IN THE EXISTING CONDITIONS OR UTILITIES THAT MAY AFFECT THE CONSTRUCTION SHOWN ON THIS PLAN.
- 9.) EXISTING CURB CUTS TO BE CLOSED OFF. NEW VERTICAL GRANITE CURB TÓ BE SET, SAWCUT EXISTING SIDEWALK, REGRADE AND PATCH THE EXISTING SIDEWALK TO MATCH EXISTING GRADES. ALL WORK TO BE DONE IN ACCORDANCE WITH THE TOWN OF FRAMINGHAM DPW RULES AND REGULATIONS.
- 10.) ALL EXISTING UTILITY SERVICE LINES TO BE ABANDONED SHALL BE CUT AND CAPPED IN ACCORDANCE WITH THE TOWN OF FRAMINGHAM DPW RULES AND REGULATIONS AND THE RESPECTIVE UTILITY SERVICE COMPANY REGULATIONS. ALL WORK TO BE COORDINATED WITH THE UTILITY COMPANIES.
- 11.) ALL UTILITY INSTALLATION TO BE IN FULL COMPLIANCE WITH THE TOWN OF FRAMINGHAM DPW RULES AND REGULATIONS.
- 12.) ALL MATERIALS IN PUBLIC AND PRIVATE WATER SYSTEMS WITHIN THE TOWN OF FRAMINGHAM'S WATER SYSTEM MUST BE "LEAD FREE."

LEGEND PROPOSED CATCH BASIN GRATE

PROPOSED DRAIN MANHOLE COVER PROPOSED SEWER MANHOLE PROPOSED DRAIN LINE PROPOSED CONTOUR

____201____ PROPOSED SPOT GRADE +201.3 + HP=204.9 + HIGH POINT PROPOSED

> DI DUCTILE IRON CI CAST IRON TC= TOP OF CURB ELEVATION

PR CB


BC= BOTTOM OF CURB ELEVATION S=0.010 PIPE SLOPE TOW= TOP OF WALL ELEVATION

PROPOSED DRAIN MANHOLE PR DMH PROPOSED OUTLET CONTROL MANHOLE PR OCM

PROPOSED CATCH BASIN


R=24' CURB RADIUS **O**•

PROPOSED LIGHT STANDARD

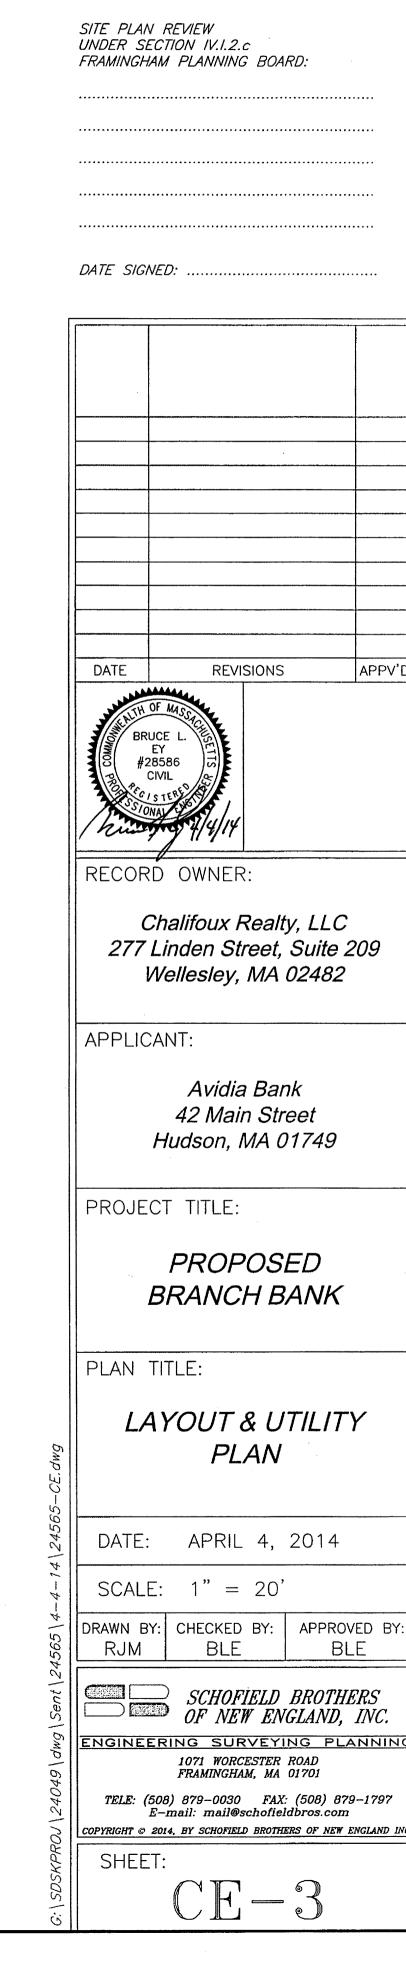

99

APPV'

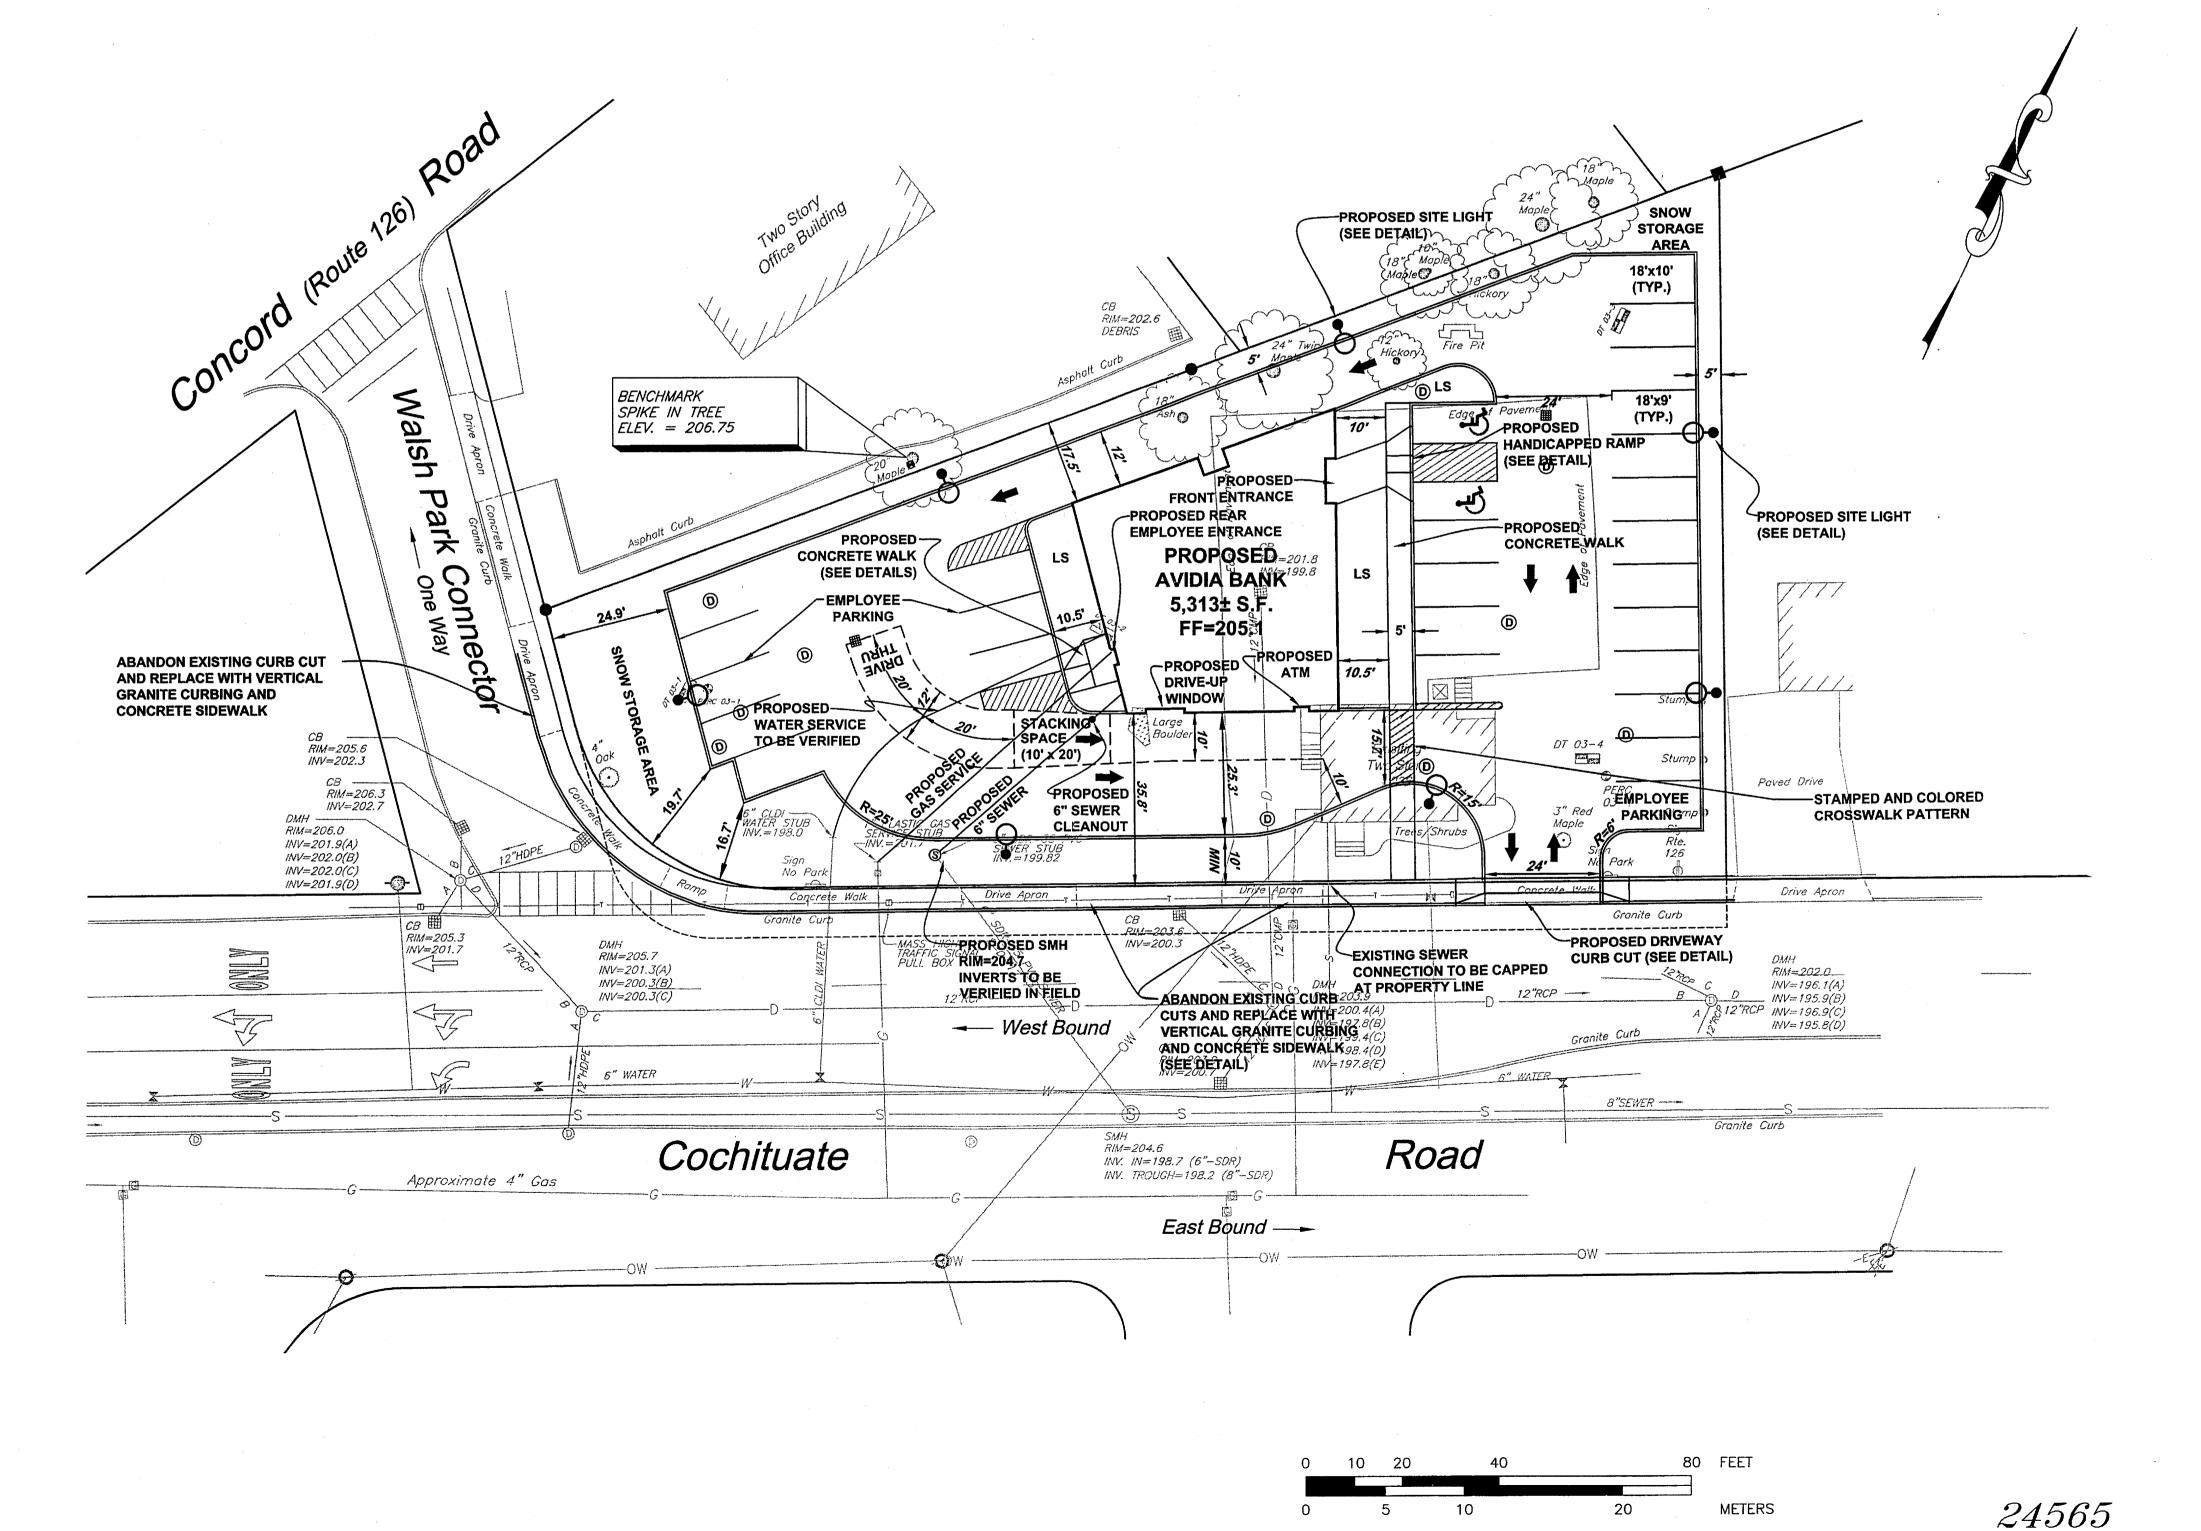

- AT AREAS OF VERTICAL GRANITE CURB AND TRANSITIONAL VERTICAL GRANITE CURB SHALL BE PROVIDED AS NECESSARY. - SEE NOTE 4 BELOW.

2.) HANDICAP PARKING SPACES AND ACCESS AISLES SHALL NOT EXCEED A SLOPE OF 1:50 (2 %) IN ANY DIRECTION.

3.) WALKWAY GRADES SHALL NOT HAVE SLOPES IN EXCESS OF 1:20 (5%) OR CROSS SLOPES IN EXCESS OF 1:50 (2%), UNLESS OTHERWISE NOTED.

4.) WALK GRADIENTS AND CROSS SLOPES SHOWN ON THE GRADING PLANS ARE WITHIN, OR LESS THAN, THE REQUIREMENTS OF THE MASSACHUSETTS ARCHITECTURAL ACCESS BOARD'S (MAAB) REGULATIONS. IT IS THE CONTRACTOR'S RESPONSIBILITY TO CONSTRUCT THE WORK SO THAT IT IS COMPLIANT WITH ALL REQUIRED REGULATIONS. NOTE THAT THE MAXIMUM GRADIENTS WITHIN THE REGULATIONS DO NOT RECOGNIZE "CONSTRUCTION TOLERANCES." EXCEEDING THE MAXIMUM GRADIENTS IN THE REGULATIONS IS ENTIRELY AT THE CONTRACTOR'S RISK. THE CONTRACTOR SHALL VERIFY IN WRITING THAT ALL WALKS HAVE BEEN CONSTRUCTED IN COMPLIANCE WITH THE MAAB'S REGULATIONS.

5.) IN CASES WHERE LEDGE OR BOULDERS ARE PRESENT, SCHOFIELD BROTHERS OF NEW ENGLAND, INC. WILL NOT BE RESPONSIBLE FOR THE AMOUNT OF ROCK ENCOUNTERED.

6.) ALL INSTALLATION AND CONSTRUCTION TO BE IN ACCORDANCE WITH THE LATEST TOWN OF FRAMINGHAM DPW REGULATIONS.

7.) SCHOFIELD BROTHERS OF NEW ENGLAND, INC. SHALL BE NOTIFIED OF ANY SIGNIFICANT DIFFERENCES IN THE EXISTING CONDITIONS OR UTILITIES THAT MAY AFFECT THE CONSTRUCTION SHOWN ON THIS PLAN.

8.) WHERE CONNECTIONS AND STRUCTURES ARE TO BE INSTALLED AT EXISTING DRAINS, THE CÓNTRACTOR IS TO CONFIRM THE LOCATION AND ELEVATION PRIOR TO THE INSTALLATION OF THE PROPOSED DRAIN SYSTEM AND IS TO NOTIFY THE ENGINEER OF ANY SIGNIFICANT DISCREPANCY FROM THE PLAN INFORMATION SHOWN.

LEGEND

PROPOSED CATCH BASIN GRATE PROPOSED DRAIN MANHOLE COVER PROPOSED SEWER MANHOLE PROPOSED DRAIN LINE -----201----- PROPOSED CONTOUR +201.3 PROPOSED SPOT GRADE + HP=204.9 + HIGH POINT PROPOSED DUCTILE IRON CI CAST IRON TC= TOP OF CURB ELEVATION BC= BOTTOM OF CURB ELEVATION S=0.010 PIPE SLOPE TOW= TOP OF WALL ELEVATION PR CB PROPOSED CATCH BASIN PR DMH PROPOSED DRAIN MANHOLE PR OCM PROPOSED OUTLET CONTROL MANHOLE CURB RADIUS R=24' PROPOSED LIGHT STANDARD

PR CB #3 WITH -**RIP-RAP APRON** RIM=203.00 INV. OUT=200.7 SEE DETAILS - PR CB #1 RIM=203.90 RIM = 202.6DEBRIS INV. OUT=202.24 SEE DETAILS BENCHMARK HEADER SPIKE IN TREE ELEV. = 206.75 5 PR DMH #2 RIM=204.40 HNV. IN=200.55 NV. OUT=200.45 L - ACCESS COVER TO FINISH GRADE AE BE SEE DETAILS & (TYP - QUANTITY:3) PROPOSED=201.8 Connector AVIDIA BANK 199.8 TC=204.9 BC=204.4 5,313± S.F. FF=205 8"HDRE -HEADER PR CB #2 RIM=203.70 INV OUT=202.34 6" CI ROOF DRAIN-INV.=NO LOWER THAN 202.30 PR RECHARGER #1 INV.S IN=202 24 INV. OUT=202.24 BOTTOM OF STONE=201.20 -ACCESS COVER TO FINISH GRADE _ (TYP - QTY:3) INV=202.3 8"HDPE S=0.0236 SEE DETAILS 8" HDPE HEADER RIM=206. INV=202.7 RIM=206.0 128" HDPE INV = 201.9(A)LAID FLAT INV = 202.0(B)INV=202.0(C) 203–203–– INV=201.9(D) PR RECHARGER #2 INV IN=202.34 INV. OUT=202.34 / Drive Apron + 202.4 + Granite Curb PR DMH #1
PR DMH #1
RIM=204.70
INV.'S IN=199.10 (8" HDPE)
204.5 INV. OUT=199.00 (8" HDPE)
SEE DETAILS RIM=20BOTTOM OF STONE=201.30
INV=201.7 SEE DETAILS
RIM=20 RIM=20\(\frac{1}{20}\) O INV=196. \(\frac{1}{2}\) -- PR OCM #1. //V=2003(R) PR OCM #2 -RIM=204.40 RIM=204.40 INV. IN=202.34 (8" HDPE) → West Bound INV=197.8(B) INV. OUT=201.7 (8" HDPE) INV=199.4(C) WEIR=202.45 SEE DETAILS INV=198.4(D) SEE DETAILS RIM=203.9 INV=197.8(E) INV=200.7 6" WATER Granite Curb Cochituate Road RIM = 204.6INV. IN=198.7 (6"-SDR) INV. TROUGH=198.2 (8"-SDR) Approximate 4" Gas East Bound — -

80 FEET

METERS


SITE PLAN REVIEW UNDER SECTION IV.1.2.c FRAMINGHAM PLANNING BOARD: DATE SIGNED: DATE REVISIONS APPV' RECORD OWNER: Chalifoux Realty, LLC 277 Linden Street, Suite 209 Wellesley, MA 02482 APPLICANT: Avidia Bank 42 Main Street Hudson, MA 01749 PROJECT TITLE: PROPOSED **BRANCH BANK** PLAN TITLE: GRADING & DRAINAGE PLAN DATE: APRIL 4, 2014 SCALE: 1"=20' DRAWN BY: CHECKED BY: APPROVED BY: BLE SCHOFIELD BRUTHERS OF NEW ENGLAND, INC. ENGINEERING SURVEYING PLANNING 1071 WORCESTER ROAD FRAMINGHAM, MA 01701 TELE: (508) 879-0030 FAX: (508) 879-1797 E-mail: mail@schofieldbros.com COPYRIGHT © 2014, BY SCHOFIELD BROTHERS OF NEW ENGLAND IN

24565

SHEET:

CE-4

BOTTOM OF CURB ELEVATION

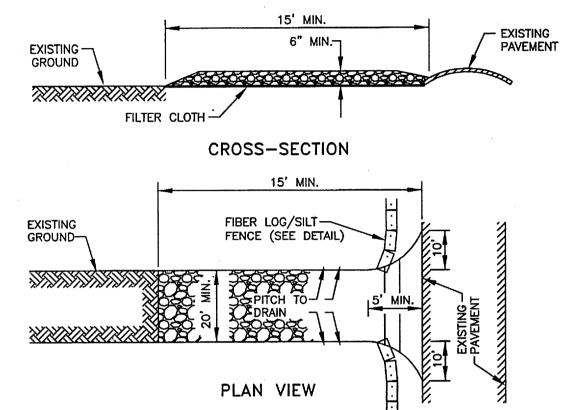

CONSTRUCTION SPECIFICATIONS:

- 1. STONE SIZE USE 3" WASHED, ANGULAR STONE
- 2. THICKNESS NOT LESS THAN SIX (6) INCHES.
- 3. WIDTH TWENTY (20) FEET MINIMUM, BUT NOT LESS THAN THE FULL WIDTH AT POINTS WHERE INGRESS OR
- 4. FILTER CLOTH SHALL BE PLACED OVER THE ENTIRE AREA PRIOR TO PLACING OF STONE.
- 5. MAINTENANCE THE ENTRANCE SHALL BE MAINTAINED IN A CONDITION WHICH SHALL PREVENT TRACKING OR FLOWING OF SEDIMENT ONTO PUBLIC RIGHTS-OF-WAY. THIS MAY REQUIRE PERIODIC TOP DRESSING WITH ADDITIONAL STONE AS CONDITIONS DEMAND AND REPAIR OR CLEANOUT OF ANY MEASURES USED TO TRAP SEDIMENT. ALL SEDIMENT SPILLED, DROPPED, WASHED OR TRACKED ONTO PUBLIC RIGHTS-OF WAY MUST BE REMOVED
- 6. PERIODIC INSPECTION AND NEEDED MAINTENANCE SHALL BE PROVIDED.

STABILIZED CONSTRUCTION ENTRANCE DETAIL (NO SCALE)

EROSION CONTROL NOTES

THE FOLLOWING ARE GENERAL EROSION CONTROL SPECIFICATIONS TO BE EMPLOYED TO PROTECT THOSE AREAS FROM ALTERATION:

1. PRIOR TO ANY DISTURBANCE OR ALTERATIONS ON ANY AREA ON THE SITE FOR THIS PROJECT, A SILT FENCE SEDIMENT BARRIER SHALL BE INSTALLED IN THE LOCATION SHOWN ON THE PLAN. IN THOSE AREAS WHERE THE TOPOGRAPHY INDICATES THAT RUNOFF WILL BE CONCENTRATED (AT LOW POINTS), HAYBALES SHALL BE STAKED ON THE UPGRADIENT SIDE OF THE FENCE FOR ADDED FILTRATION OF THE RUNOFF AND PROTECTION. SOME OF THESE LOCATIONS ARE SHOWN ON THE PLAN AND OTHER REQUIRED LOCATIONS FOR THE HAYBALE INSTALLATION WILL BE SELECTED BY THE ENGINEER AND OR THE TOWN OF FRAMINGHAM UPON COMPLETION OF THE SILT FENCE INSTALLATION (SEE DETAIL ON THE PLAN).

2. ONCE INSTALLED, THE STAKED HAYBALE & SILT FENCE SEDIMENT BARRIERS SHALL BE MAINTAINED IN PLACE UNTIL ALL AREAS UPGRADIENT HAVE BEEN STABILIZED AS SPECIFIED HEREIN. UPON COMPLETION OF THE PROJECT AND ACCEPTANCE BY THE TOWN OF FRAMINGHAM, THE SILT FENCE AND HAYBALES SHALL BE REMOVED.


3. THE STAKED HAYBALE & SILT FENCE SEDIMENT BARRIERS ARE ALSO INTENDED TO ACT AS A LIMIT OF DISTURBANCE. ANY LAND DOWNGRADIENT FROM THE BARRIER ACCIDENTALLY DISTURBED SHALL BE IMMEDIATELY REPAIRED AND RESTORED TO ORIGINAL CONDITION.

4. ALL DISTURBED AREAS NOT OTHERWISE DEVELOPED OR WHERE SPECIAL STABILIZATION MEASURES OR LANDSCAPE PLANTINGS ARE NOT PROPOSED SHALL BE LOAMED AND SEEDED. FOUR INCHES OF LOAM TOPSOIL (MINIMUM) SHALL BE APPLIED AND THE AREA SEEDED WITH AN UPLAND


5. ALL AREAS OUTSIDE THE LIMIT OF WORK ARE TO BE LEFT UNDISTURBED. DURING THE SITE WORK, ALL PERSONS AND EQUIPMENT SHALL STAY OUTSIDE OF THESE AREAS TO PRESERVE THE EXISTING VEGETATION.


DEWATERING OF EXCAVATIONS NOTES: 1. DISCHARGE FROM DEWATERING PUMPS OR TEMPORARY TRENCH OR EXCAVATION DRAINS SHALL NOT DISCHARGE DIRECTLY TO EXISTING DRAIN SYSTEMS. THE DISCHARGES SHALL BE DIRECTED INTO A FILTER BAG SPECIFICALLY DESIGNED FOR DEWATERING.

CATCH BASIN PROTECTION 1. ANY CATCH BASIN THAT RECEIVES RUNOFF FROM THE UNSTABILIZED WORK AREA SHALL BE PROTECTED WITH A "SILT SACK" OR APPROVED EQUAL UNTIL THE TRIBUTARY AREA IS IN A STABILIZED CONDITION.

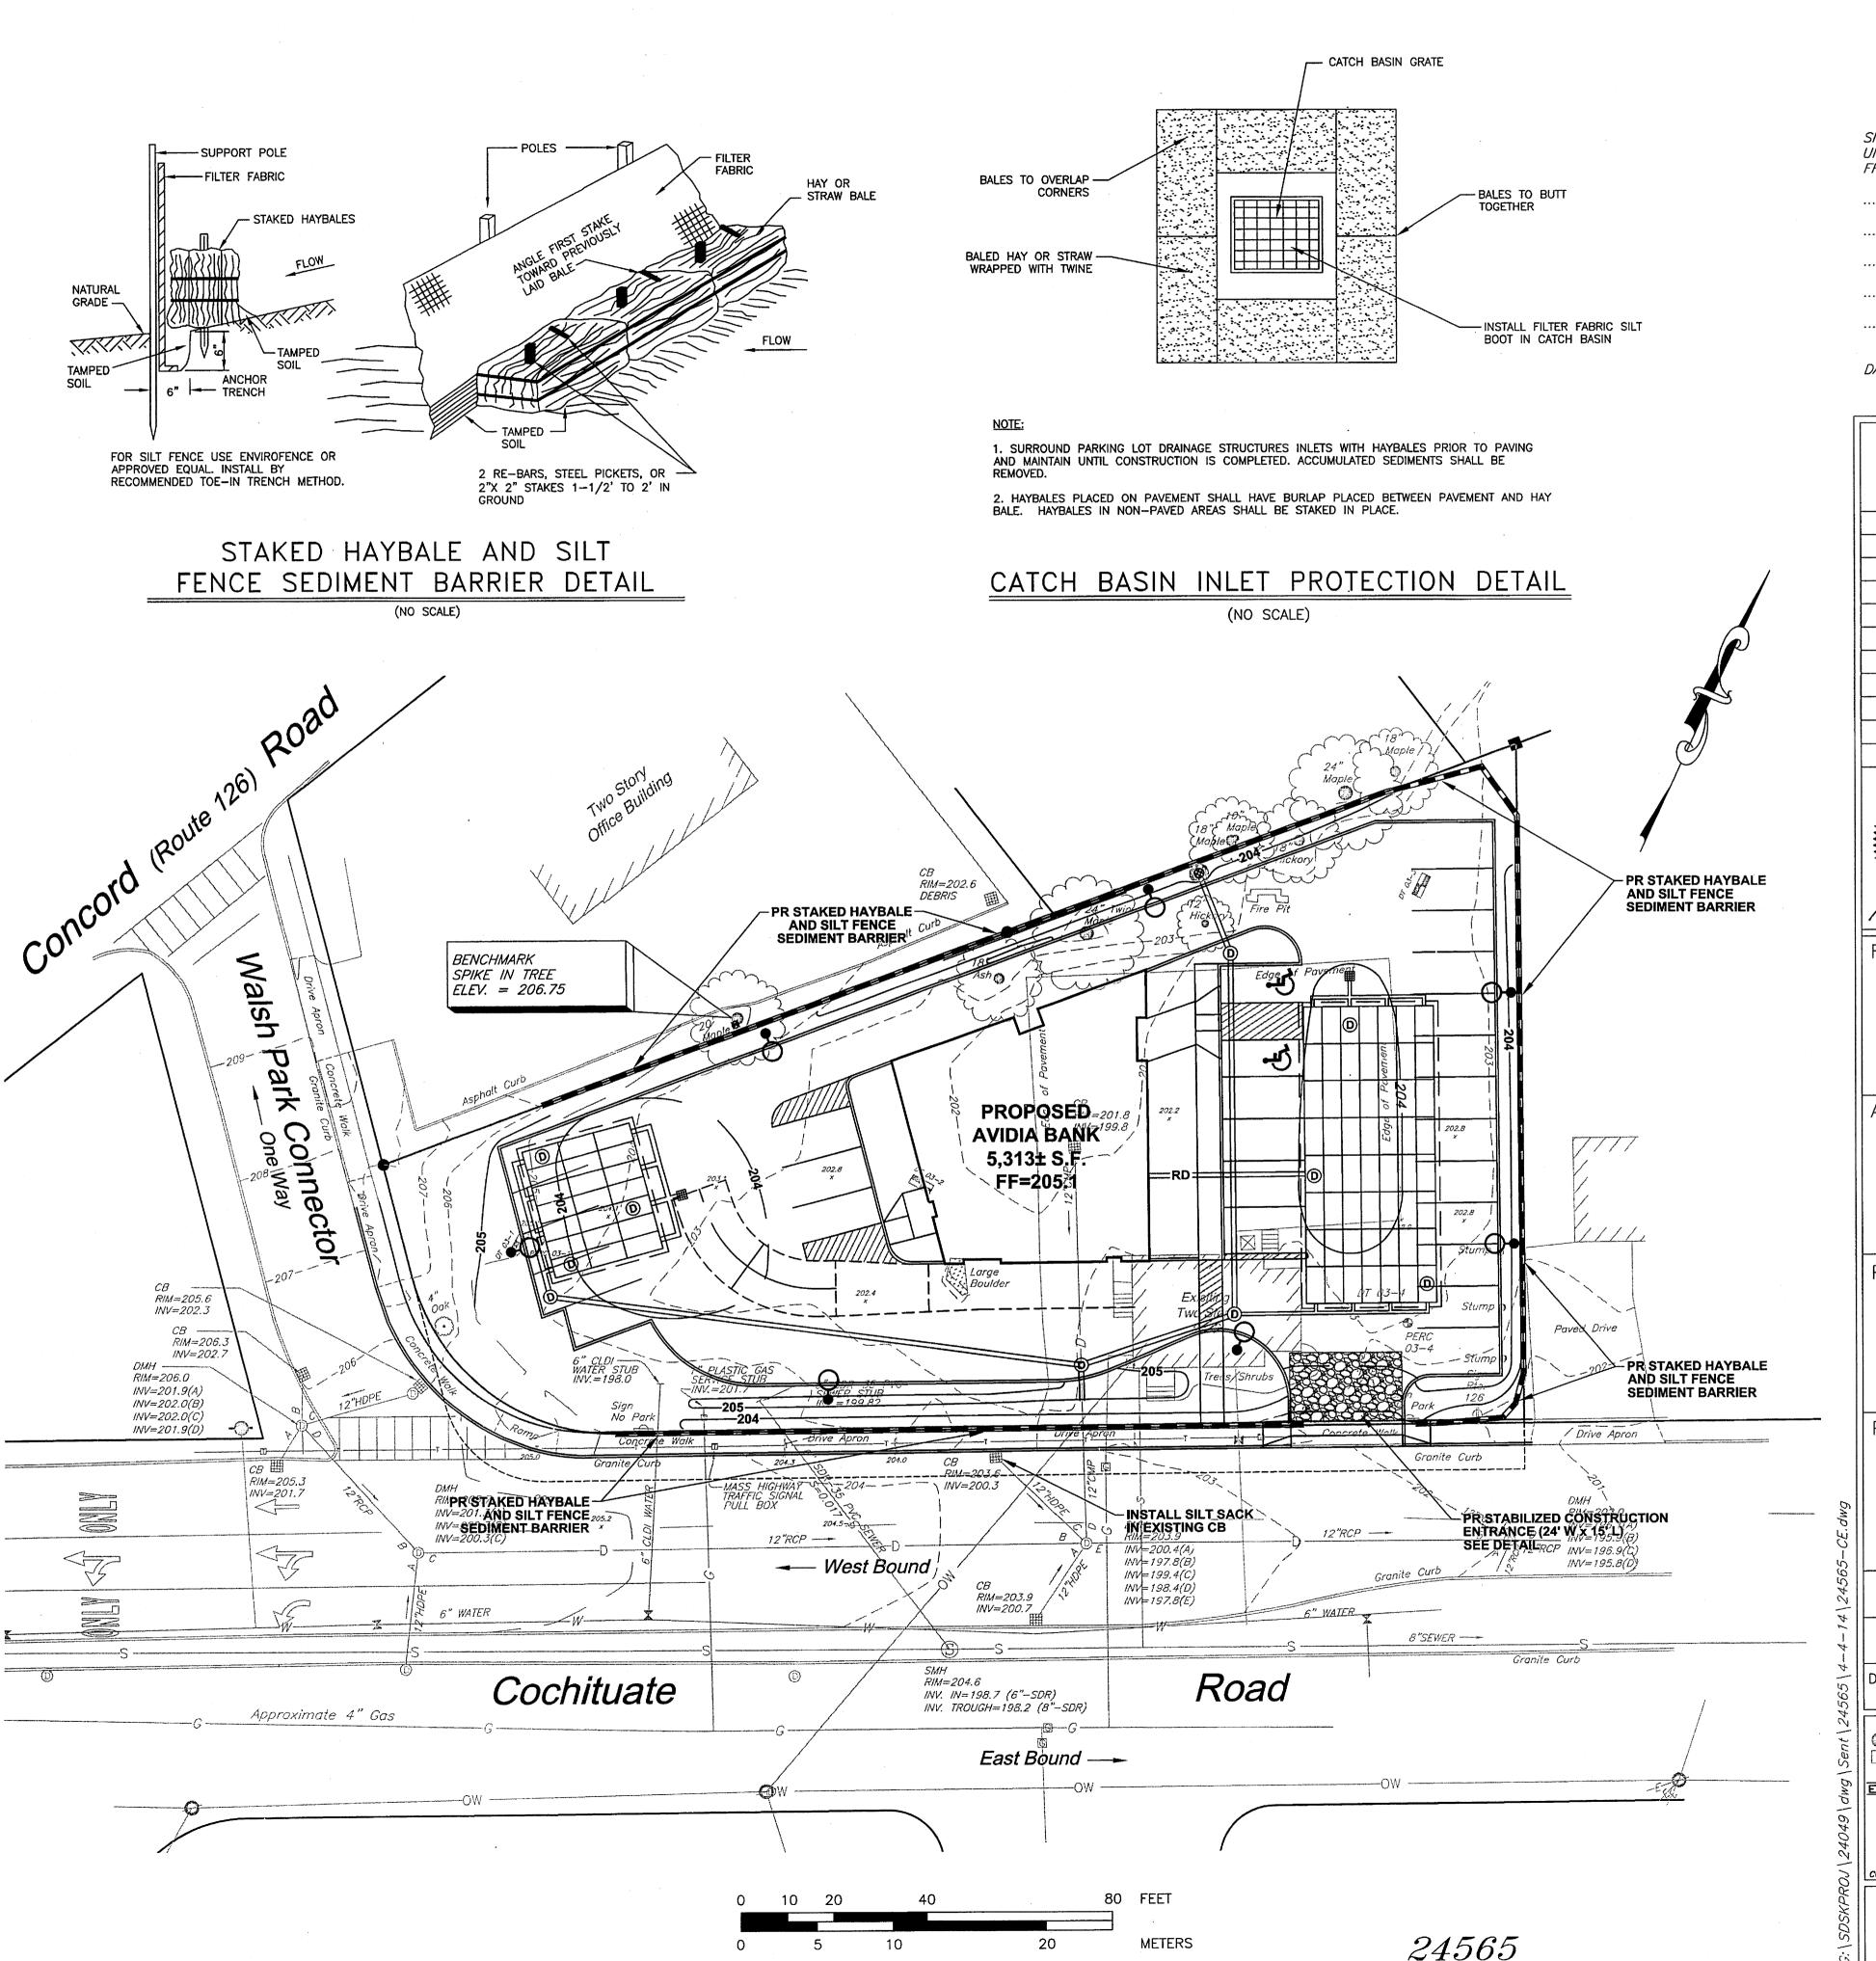

SITE PLAN REVIEW UNDER SECTION IV.I.2.c FRAMINGHAM PLANNING BOARD: DATE SIGNED:

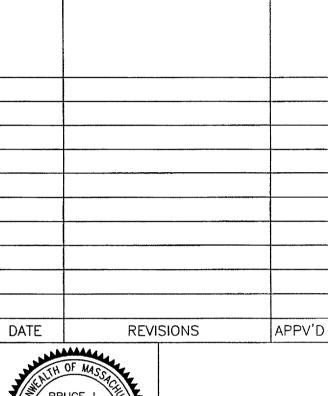

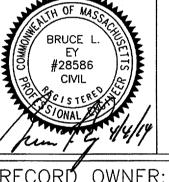

Chalifoux Realty, LLC 277 Linden Street, Suite 209 Wellesley, MA 02482

APPLICANT:

Avidia Bank 42 Main Street Hudson, MA 01749

PROJECT TITLE:

PROPOSED **BRANCH BANK**

PLAN TITLE:

EROSION & SEDIMENTATION CONTROL PLAN & **DETAILS**


DATE: APRIL 4, 2014 SCALE: 1"=20'

DRAWN BY: CHECKED BY: APPROVED BY: BLE BLE RJM

SCHOFIELD BROTHERS OF NEW ENGLAND, INC. ENGINEERING SURVEYING PLANNING 1071 WORCESTER ROAD FRAMINGHAM, MA 01701

COPYRIGHT © 2014, BY SCHOFIELD BROTHERS OF NEW ENGLAND INC.

SHEET: CE-5

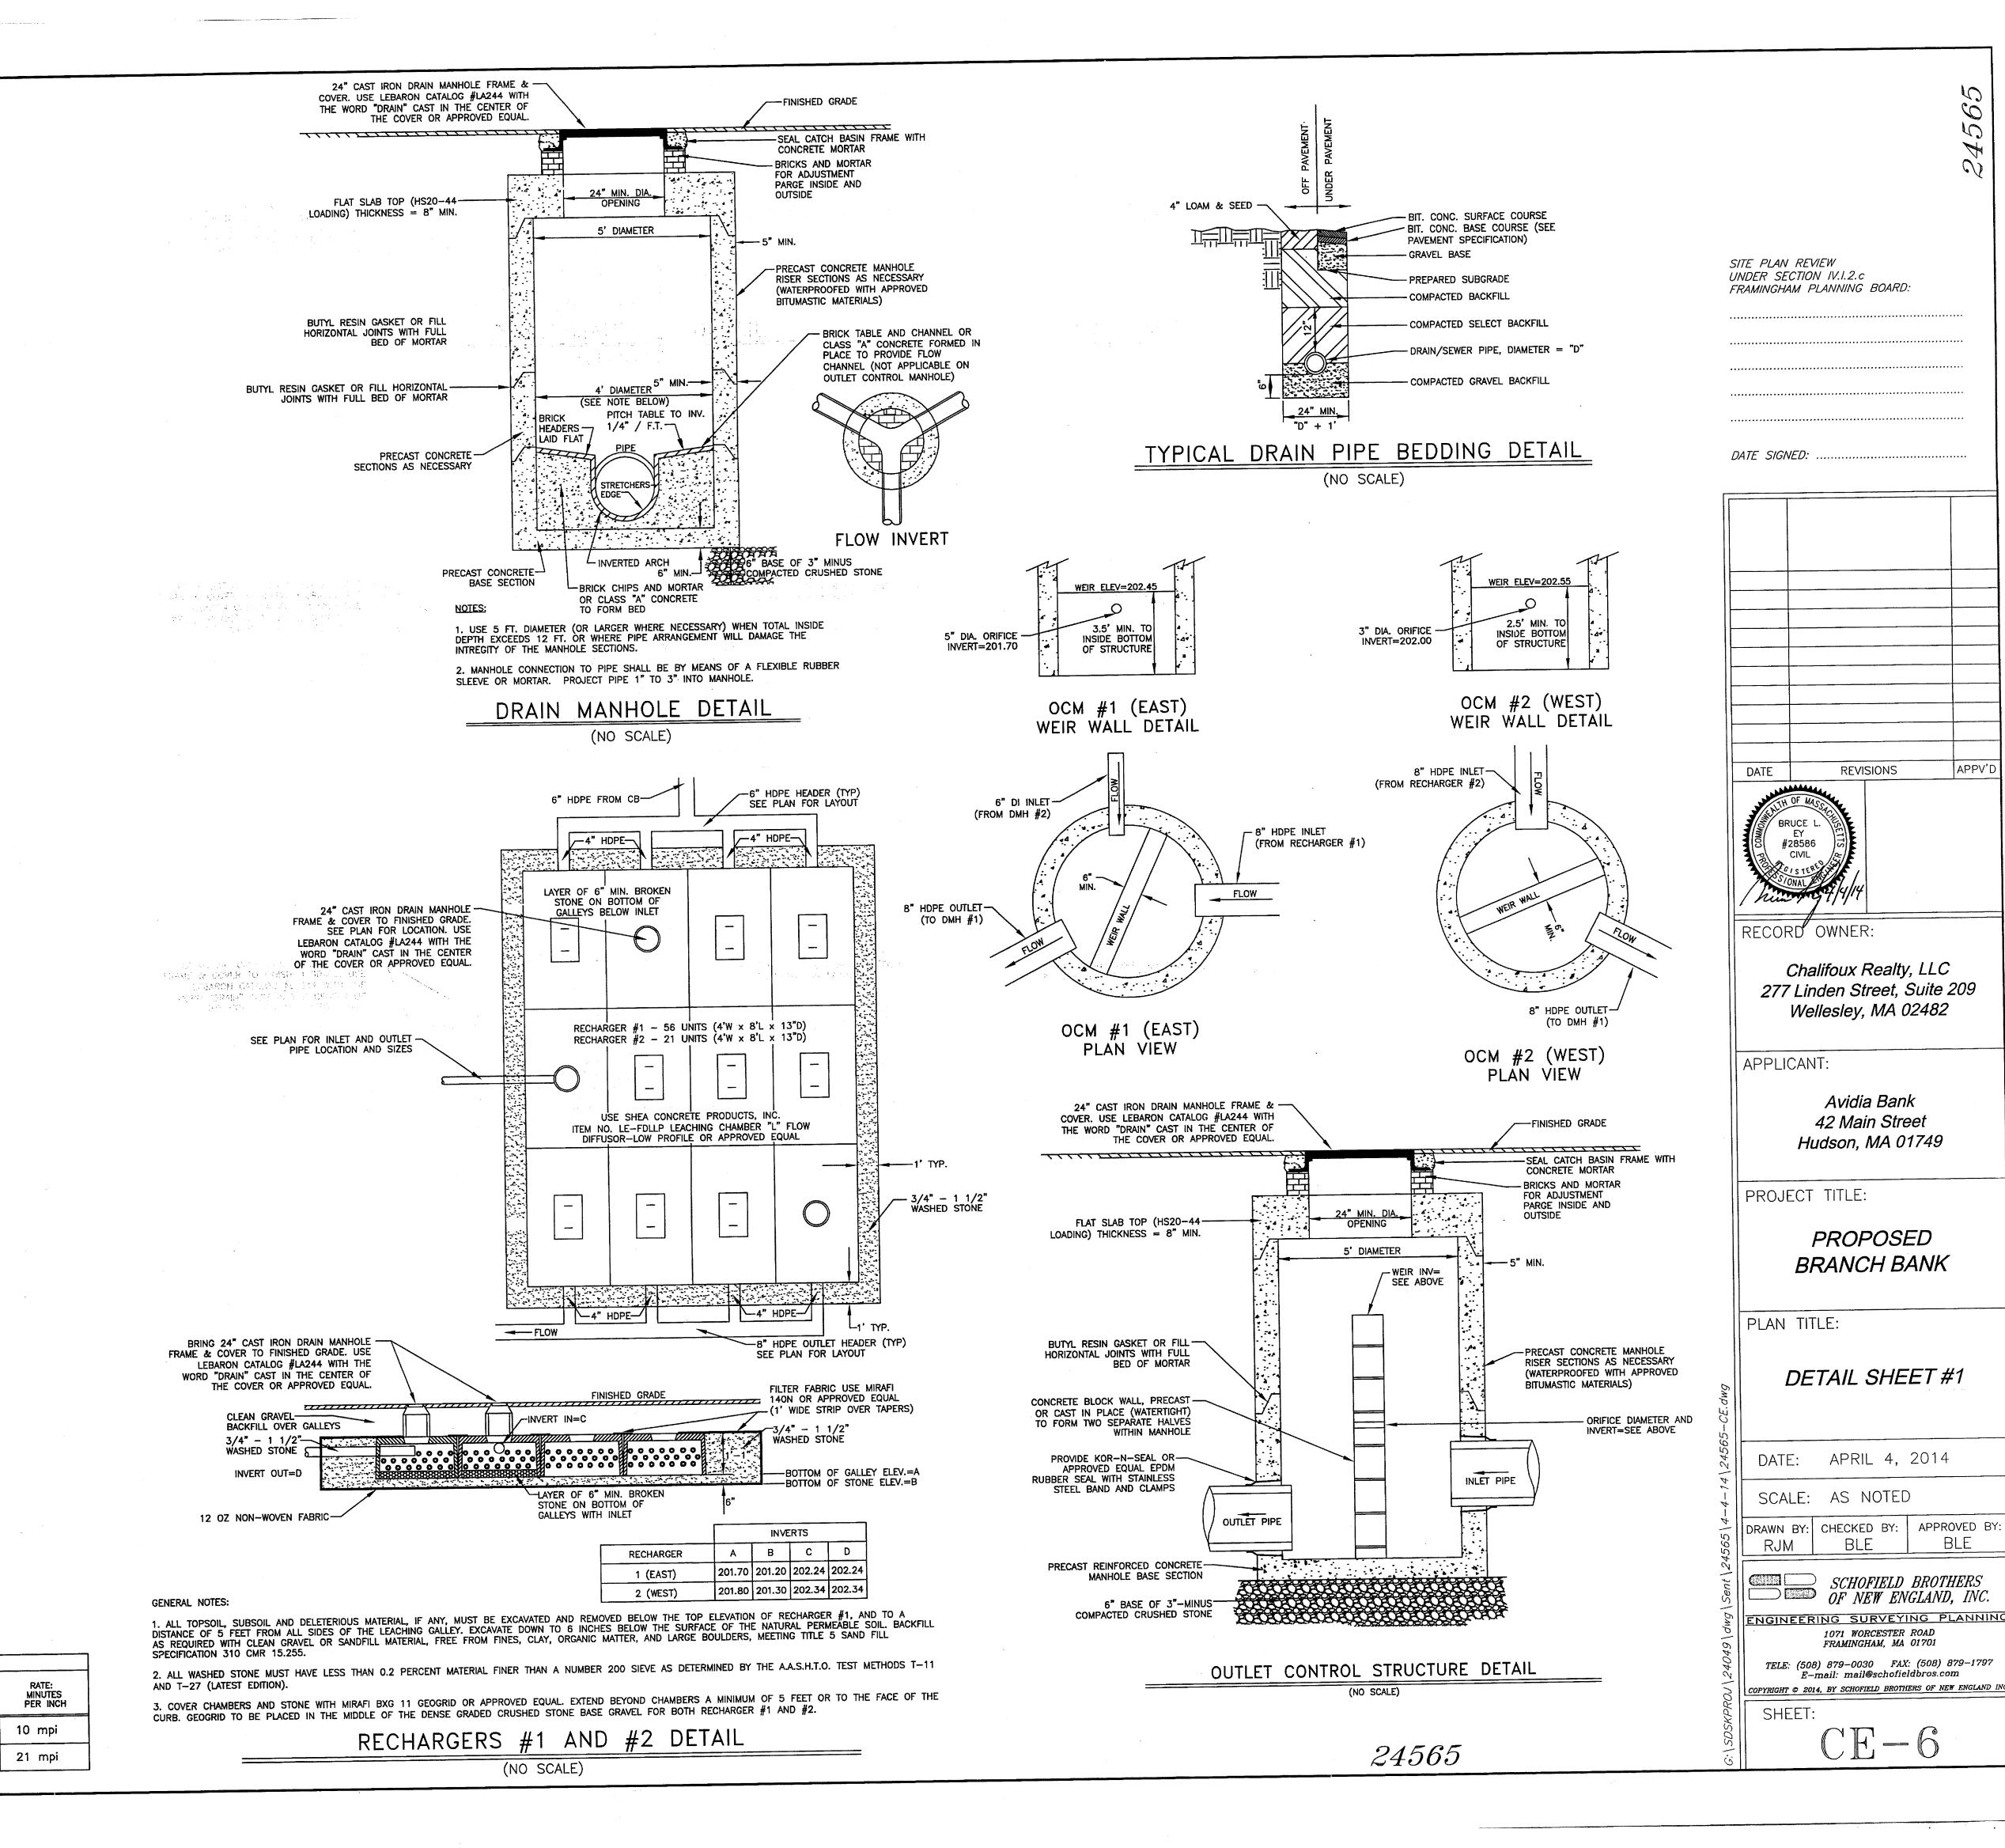

APPV'

BLE

DEEP OBSERVATION HOLE # 03-1 LOG

Sandy Loam

Sandy Loam

Sandy Loam

WEEPING FROM PIT FACE: \$\\\ 936\], STANDING WATER IN HOLE: \$\\\ 60\] MONITOR WELL ELEVATION: _____, MONITOR WELL READING: _____, DATE: ____

DEEP OBSERVATION HOLE # 03-2 LOG

Sandy Loam

Sandy Loam

Sandy Loam

DEEP OBSERVATION HOLE # 03-3 LOG

Sandy Loam

Sandy Loan

Refusal

DEEP OBSERVATION HOLE # 03-4 LOG

Sandy Loam

Sandy Loam

WEEPING FROM PIT FACE: <u>\$\Pi\$48</u>, STANDING WATER IN HOLE: <u>\$\Pi\$96</u>, MONITOR WELL ELEVATION: _____, MONITOR WELL READING: _____, DATE: _____

SURFACE

ELEVATION

204.6

202.3

C1

C2

SOIL HORIZON

PARENT MATERIAL (GEOLOGICAL): Glacial Till

SOIL HORIZON

SURFACE ELEVATION: 202.8

PARENT MATERIAL (GEOLOGICAL): _

Fill

SURFACE ELEVATION: 202.9

PARENT MATERIAL (GEOLOGICAL): _

DEPTH TO GROUNDWATER:

TEST PIT NO.

03-1

03-4

DATE

2/22/03

12/22/03

SURFACE ELEVATION: 205.1

PARENT MATERIAL (GEOLOGICAL): _ DEPTH TO GROUNDWATER:

10YR 3/3 | None Observed |

GROUNDWATER ADJUSTMENT FACTOR: ____, ESTIMATED SEASONAL HIGH GROUNDWATER ELEVATION: @36" by soil morphology

GROUNDWATER ADJUSTMENT FACTOR: ____, ESTIMATED SEASONAL HIGH GROUNDWATER ELEVATION: @30" by soil morphology

WEEPING FROM PIT FACE: \$\oldsymbol{\text{G}}30\oldsymbol{\text{M}}, standing water in hole: \$\oldsymbol{\text{G}}54\oldsymbol{\text{M}}.

MONITOR WELL ELEVATION: _____, MONITOR WELL READING: _____, DATE: ______

GROUNDWATER ADJUSTMENT FACTOR: _____, ESTIMATED SEASONAL HIGH GROUNDWATER ELEVATION: \$\oldsymbol{\text{G}}30\oldsymbol{\text{M}}\$ by soil morphology

10YR 3/2 | None Observed

GROUNDWATER ADJUSTMENT FACTOR: ____, ESTIMATED SEASONAL HIGH GROUNDWATER ELEVATION: @36" by soil morphology

DEPTH FROM TOP OF PIT

38"

None Observed

2.5YR 4/6

PERCOLATION TEST DATA

ELEVATION

202.3

199.1

TOP OF 12" OF WATER

SOIL MOTTLING

SOIL MOTTLING

None Observed

None Observed | M-F, few stones

None Observed | M-F, some stones

10YR 5/6

10YR 5/4

SOIL COLOR

10YR 3/3

2.5Y 5/4

SOIL COLOR

10YR 3/3

2.5Y 5/4

SOIL COLOR

10YR 5/6

DEPTH FROM SURFACE

0 - 8"

8 - 16"

16 - 36"

DEPTH FROM SURFACE

0 - 8"

8 - 16"

16 - 84"

8 - 16"

DEPTH FROM SURFACE

0 - 24"

36 - 120"

SURFACE ELEVATION: _____202.2

DEPTH TO GROUNDWATER:

DATE: 12/22/03

M-F, few stones

M—F, gravelly till w/

pockets of silts and clays

DATE: 12/22/03

M-F, gravelly till w/

DATE: 12/22/03

M-F, gravelly till w/ pockets of silts and clays

DATE: 12/22/03

M-F, some stones

M-F, some stones

DEPTH TO BEDROCK: >120"

M—F, gravelly till w/

pockets of silts and clays

INTERVAL TIME

(MINUTES)

12" - 9" | 9" - 6"

28

M-F, few stones

Ledge/Boulders


; DEPTH TO BEDROCK: 84"

; DEPTH TO BEDROCK: >84"

None Observed | Med. to Coarse sand w/

few stones

DEPTH TO BEDROCK: >90"

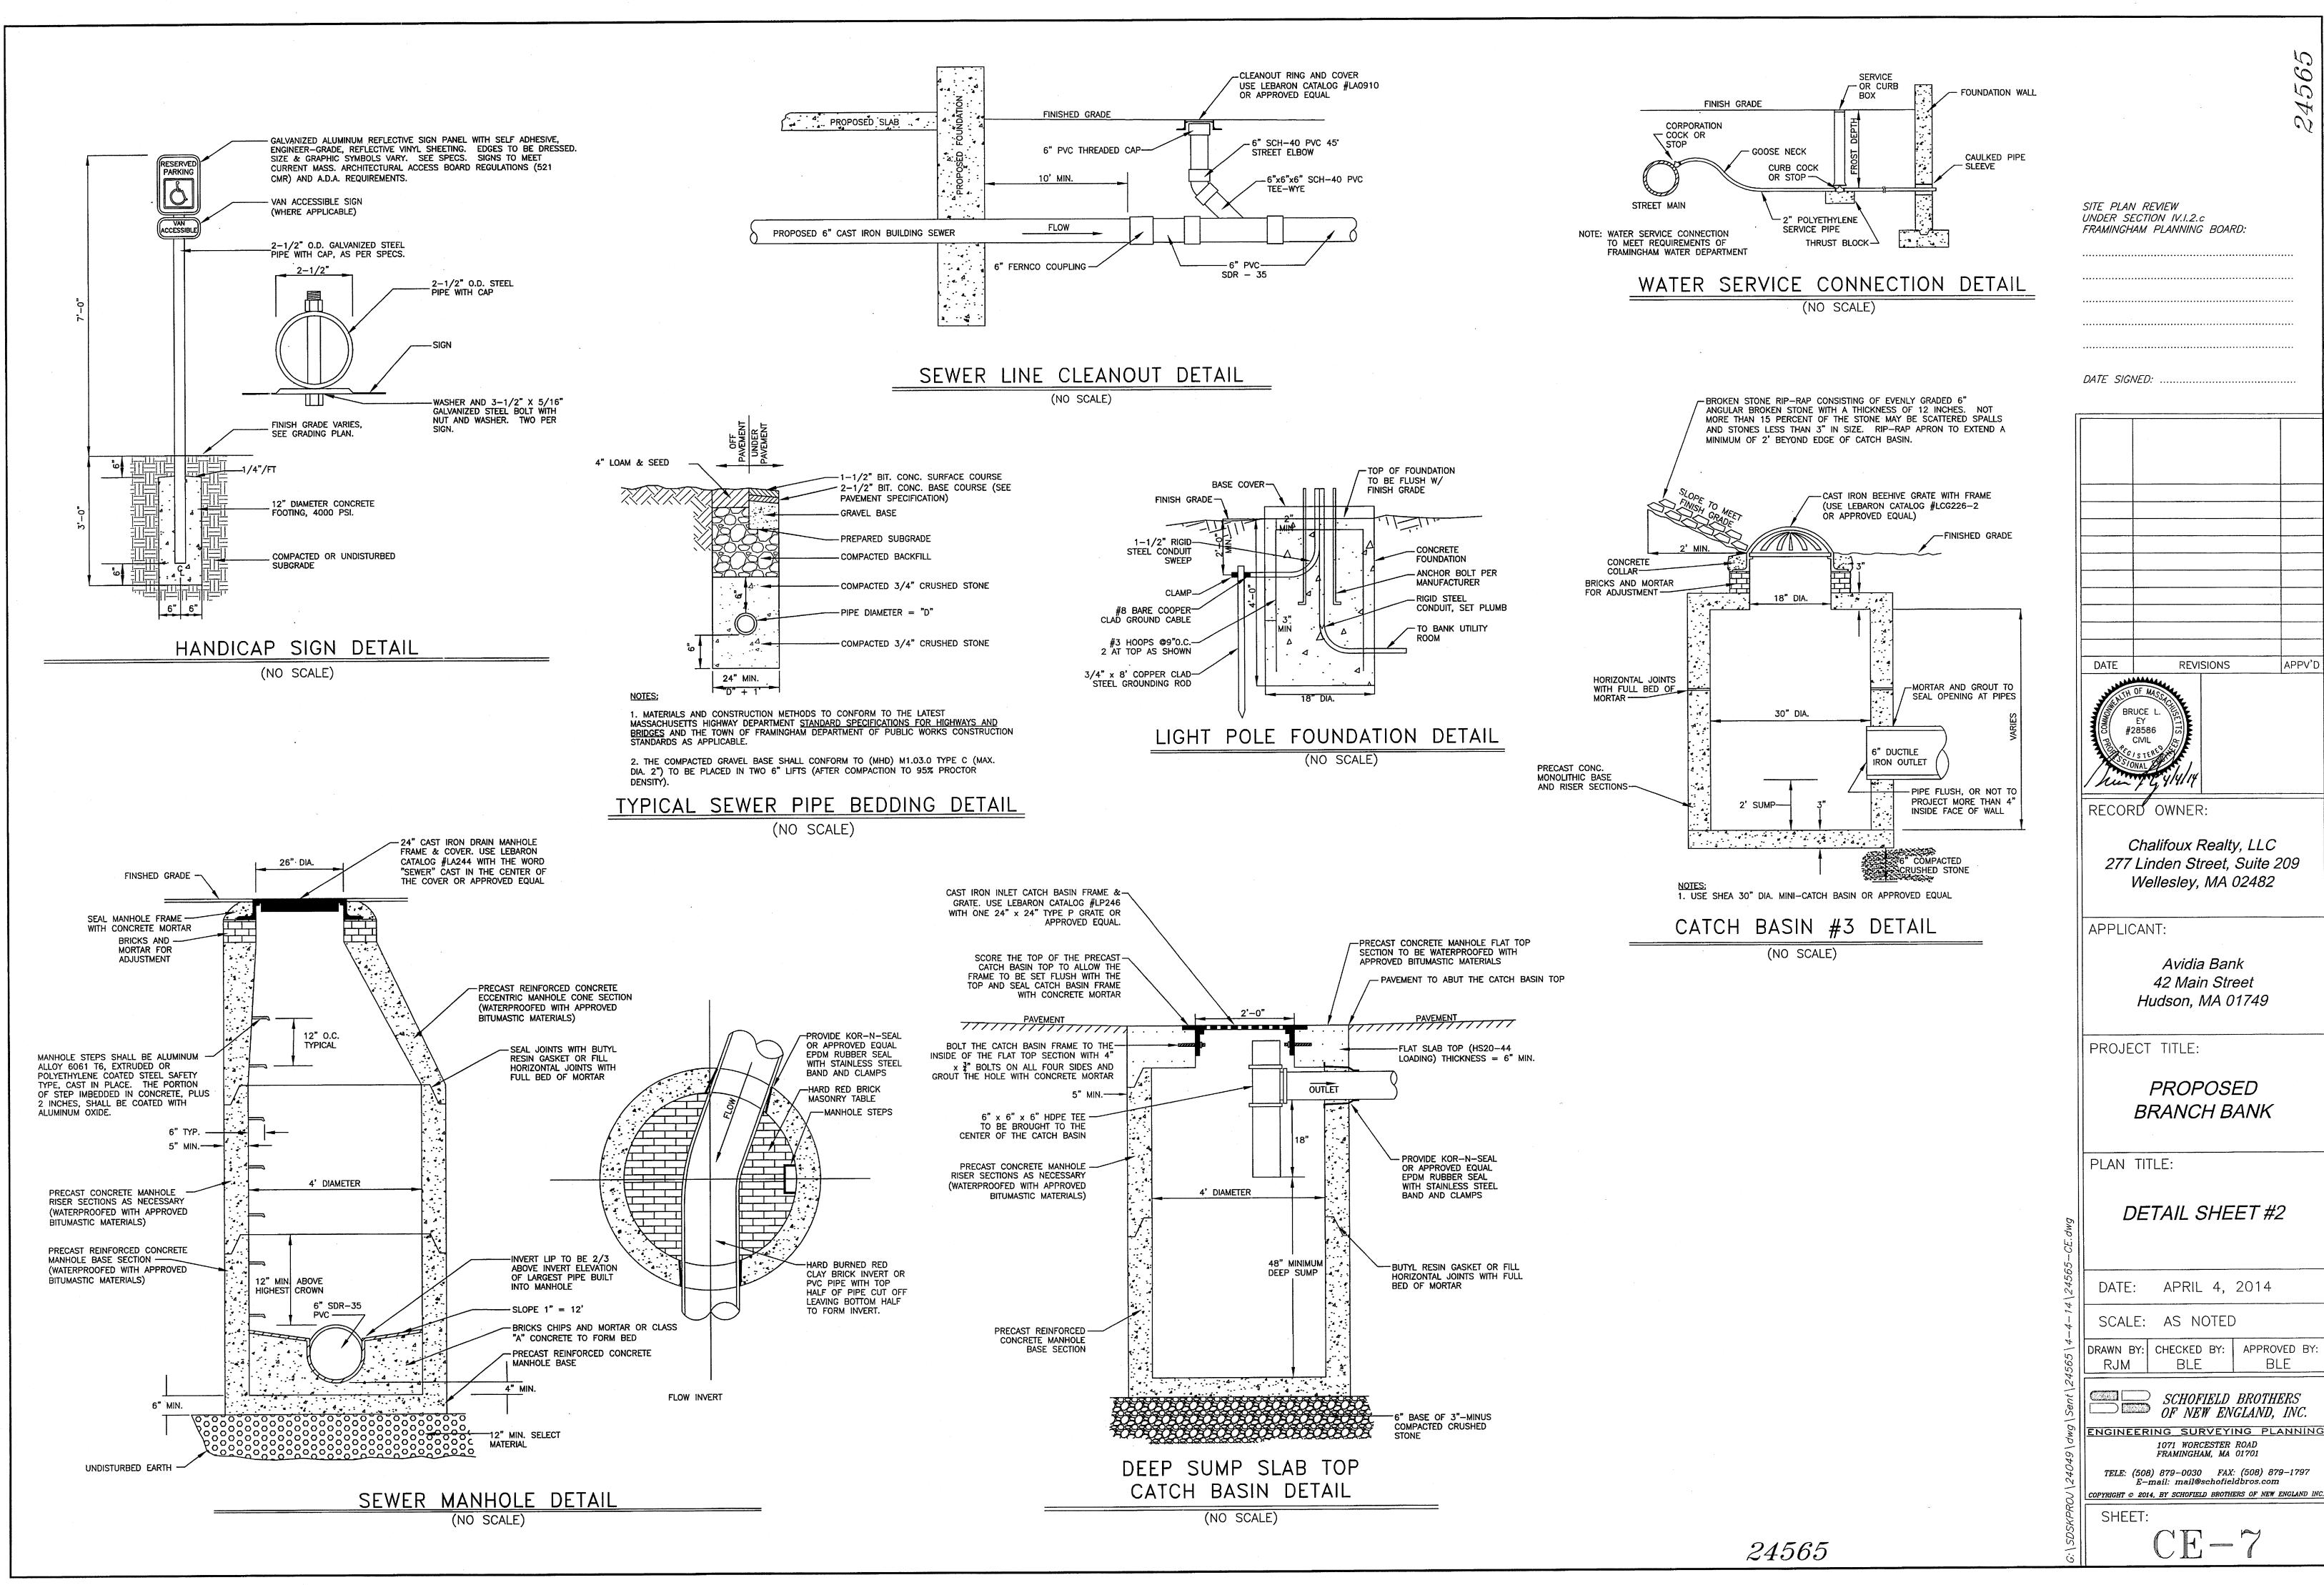

UNDER SECTION IV.I.2.c FRAMINGHAM PLANNING BOARD: APPV'C REVISIONS Chalifoux Realty, LLC 277 Linden Street, Suite 209 Wellesley, MA 02482 Avidia Bank 42 Main Street Hudson, MA 01749 PROJECT TITLE: PROPOSED **BRANCH BANK** DETAIL SHEET #2 DATE: APRIL 4, 2014 SCALE: AS NOTED DRAWN BY: CHECKED BY: APPROVED BY: BLE SCHOFIELD BROTHERS

